


41 MONBULK ROAD, MOUNT EVELYN VIC 3796


COLOURS & FINISHES SCHEDULE



NORTH ELEVATION

1:100 AT A1

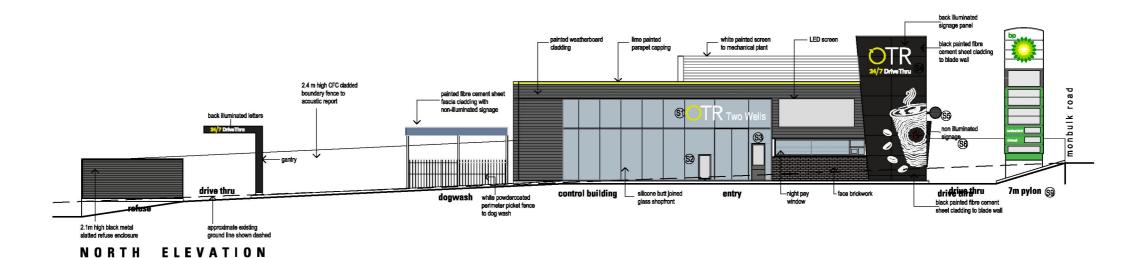

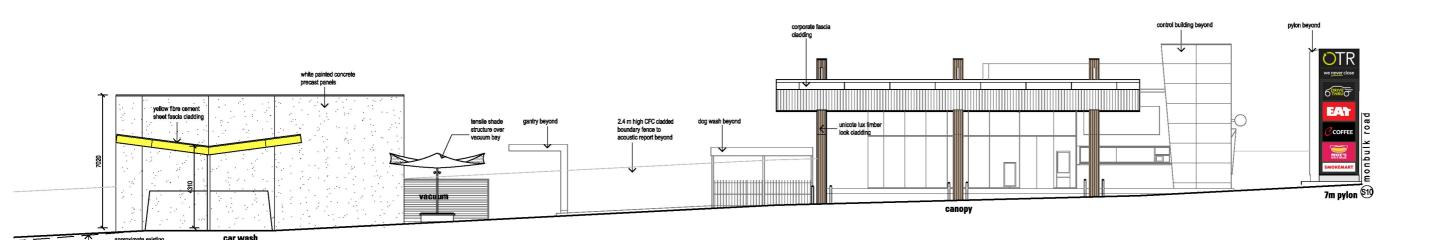

SOUTH ELEVATION


1:10 AT A1


OTR MOUNT EVELYN

41 MONBULK ROAD, MOUNT EVELYN VIC 3796


1:100 AT A1

0 1 2 5 10 Scale 1:100 at A1

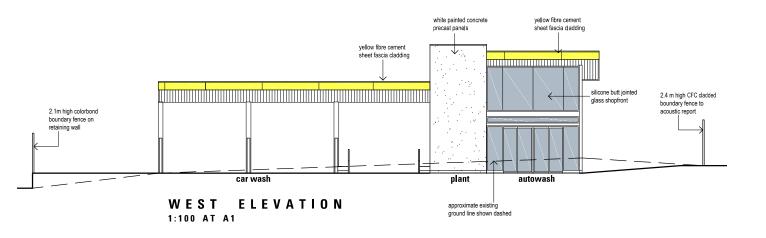


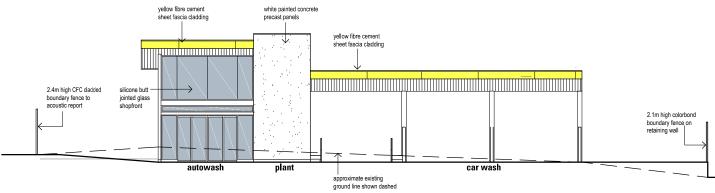

EAST ELEVATION
1:100 AT A1

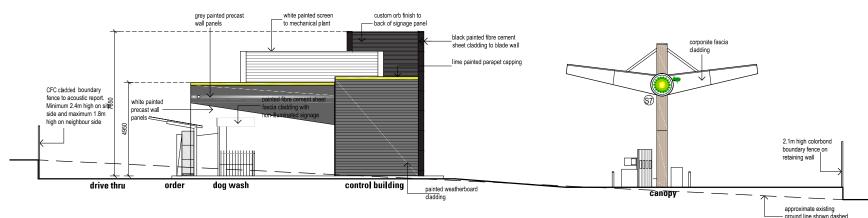

EAST ELEVATION

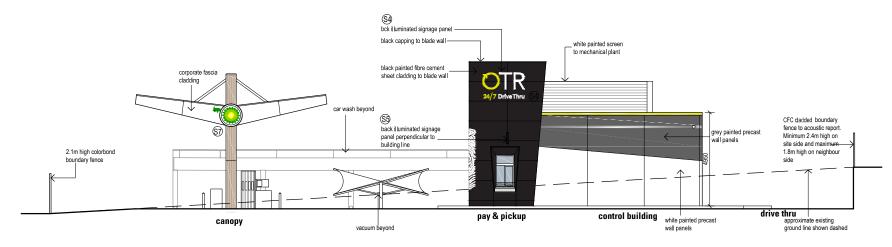

WEST ELEVATION
1:100 AT A1


OTR MOUNT EVELYN


41 MONBULK ROAD, MOUNT EVELYN VIC 3796

COLOURS & FINISHES SCHEDULE


ITEM	MATERIAL	COLOUR
shopfront	glass	clear
blade wall (left side)	weatherboard cladding	grey
blade wall (right side)	CFC sheet cladding	dark grey/black
main bldg. canopy overhang	weatherboard cladding	grey with top lime painted flashing
night pay window wall	face brick	as shown
roof top plant screen	weatherboard	white
pay & pickup window	no pre core alucobond	dark grey
Fuel Canopy columns	Unicote Lux sheet cladding	timber look
Fuel Canopy overhang	Alucobond sheet cladding	white
autowash	glass	clear
autowash fascia	CFC sheet cladding	yellow
carwash	precast	white
carwash fascia	CFC sheet cladding	yellow
plant room	precast panels	white
refuse	metal slats	black

0 1 2 5 10m Scale 1:100 at A1

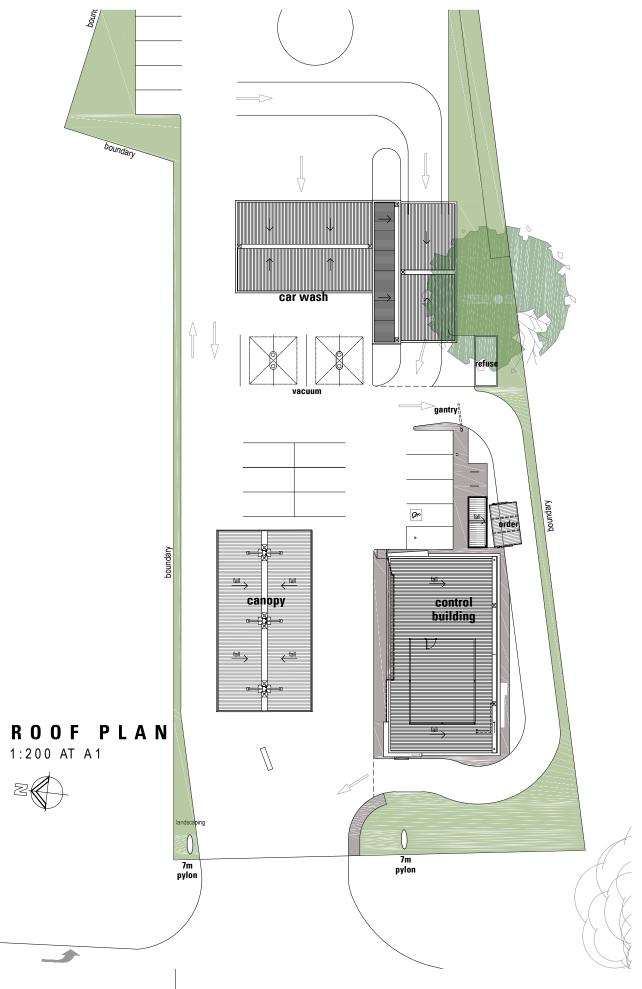

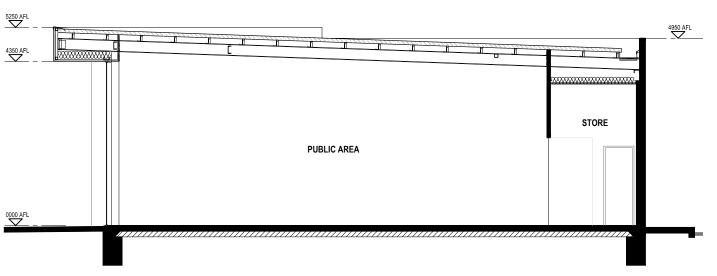


TYPICAL SCHEMATIC SECTION 1:50 AT A1

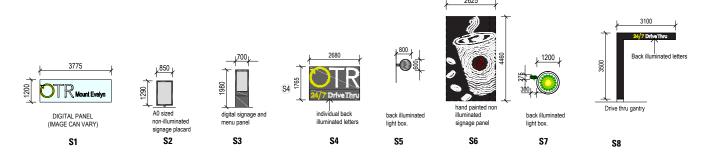


SIGNAGE ELEVATIONS

1:100 AT A1

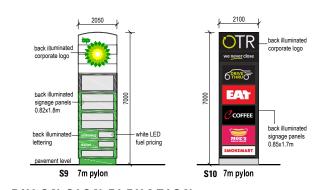

PYLON SIGN ELEVATION 1:100 AT A1

41 MONBULK ROAD, MOUNT EVELYN VIC 3796

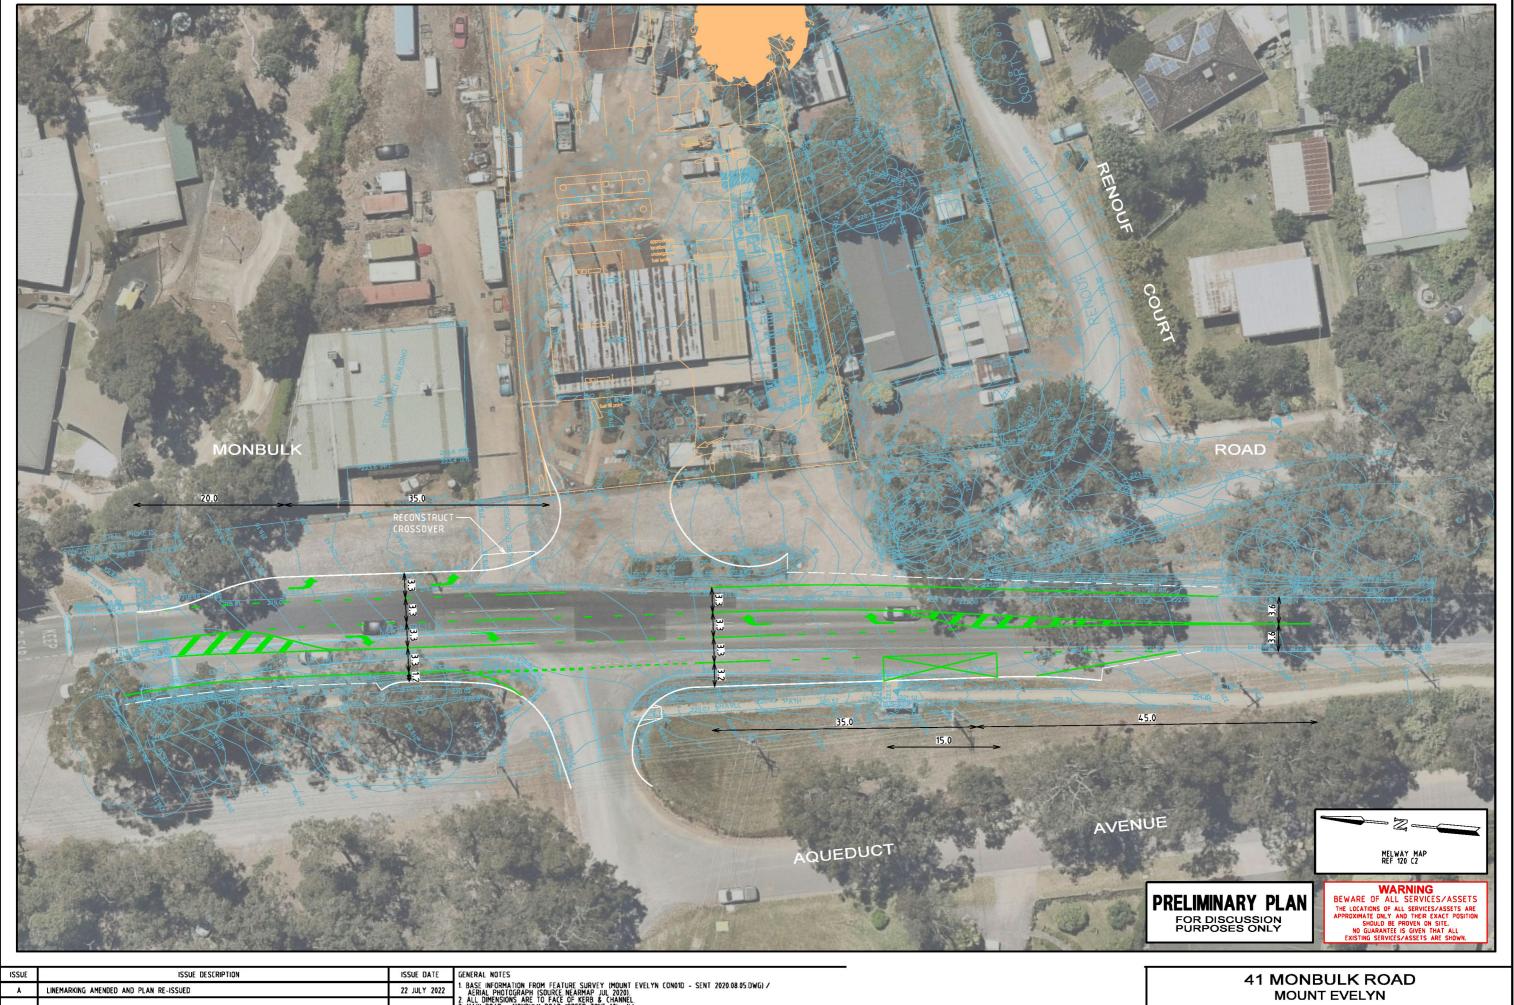

	15502 5252111 11511	ISSUE DATE	denemie notes
A	LINEMARKING AMENDED AND PLAN RE-ISSUED	22 JULY 2022	1. BASE INFORMATION FROM FEATURE SURVEY (MOUNT EVELYN CONOID - SENT 2020.08.05.DWG) / AERIAL PHOTOGRAPH (SOURCE NEARMAP JUL 2020).
			2. ALL DIMENSIONS ARE TO FACE OF KERB & CHANNEL. 3. MAIN ROAD - MONBULK ROAD (SPEED ZONE 60km/h).
			A. ALL PROPOSED FOOTPATHS AND PRAM CROSSINGS ARE TO BE CONSTRUCTED WITH TACTILE GROUND SURFACE INDICATORS TO DDA COMPLIANCE GUIDELINES REFER TO AS 1428.4.2009.

YARRA RANGES SHIRE COUNCIL FUNCTIONAL LAYOUT PLAN SCALE 0 2.5 5 7.5 10 SHEET No. DWG No. G27274-02-01



Construction BAL Rating = 29

N 50

Bushfire Mitigation Measures - Mandatory Condition

The bushfire protection measures forming part of this permit or shown on the endorsed plans, including those relating to construction standards, defendable space, water supply and access, must be maintained to the satisfaction of the responsible authority on a continuing basis. This condition continues to have force and effect after the development authorised by this permit has been completed

a) Defendable Space

Defendable space is provided for a distance of **50 metres** around the building or to the property boundary whichever is the lesser and managed in accordance with the following:

- Grass must be short cropped and maintained during the declared fire danger period.
- All leaves and vegetation debris must be removed at regular intervals during the declared fire danger period.
- Within 10 metres of a building, flammable objects must not be located close to the vulnerable parts of the building.
- Plants greater than 10 centimetres in height must not be placed within 3m of a window or glass feature of the building.
- Shrubs must not be located under the canopy of trees.
- Individual and clumps of shrubs must not exceed 5 sq. metres in area and must be separated by at least 5 metres.
- Trees must not overhang or touch any elements of the building.
- The canopy of trees must be separated by at least 5 metres
- There must be a clearance of at least 2 metres between the lowest tree branches and ground level.

b) Construction Standard

Dwelling designed and constructed to a minimum Bushfire Attack Level of **BAL29**

c) Water Supply

A static water tank dedicated solely for firefighting must be provided and must meet the following requirements:

- An effective capacity of 10,000 Litres
- Be stored in an above ground water tank constructed of concrete or metal.
- Have all fixed above ground water pipes and fittings required for firefighting purposes made of corrosive resistant metal.
- Include a separate outlet for occupant use.

A 10,000 litre water supply is required, therefore the following fire authority fittings and access must be provided:

- Be readily identifiable from the building or appropriate identification signage to the satisfaction of the relevant fire authority.
- Be located within 60 metres of the outer edge of the approved building.
- The outlet/s of the water tank must be within 4 metres of the accessway and unobstructed.
- Incorporate a separate ball or gate valve (British Standard Pipe (BSP 65 millimetre) and coupling (64 millimetre CFA 3 thread per inch male fitting).
- Any pipework and fittings must be a minimum of 65 millimetres (excluding the CFA coupling).

d) Access

Access Required: **Yes.** The following design and construction requirements apply:

- All-weather construction.
- A load limit of at least 15 tonnes.
- Provide a minimum trafficable width of 3.5 metres.
- Be clear of encroachments for at least 0.5 metres on each side and at least 4 metres vertically.
- Curves must have a minimum inner radius of 10 metres.
- The average grade must be no more than 1 in 7 (14.4%) (8.1°) with a maximum grade of no more than 1 in 5 (20%) (11.3°) for no more than 50 metres
- Dips must have no more than a 1 in 8 (12.5%) (7.1han 050 metres.) entry and exit angle.

nts						
	CLIENT: PC I	NFRASTRUCTU	RE			
t	TITLE: BUSHFIRE MANAGEMENT PLAN					
)	PROJECT: NEW COMMERCIAL BUILDING 41 Monbulk Road Mount Evelyn					
У	NORTH:	DRAWN: LH CHECKED:	DATE: 13.02.2022 SCALE @ A3:			
	PROJECT NO: 21007	DH DRAWING NO: 101	AS SHOWN REVISION:			

BUILDING PERMIT

STATUS:

1 BUSHFIRE MANAGEMENT PLAN

NOTES

EXISTING SERVICES THE CONTRACTOR MUST LOCATE AND MARK ALL UNDERGROUND SERVICES BEFORE COMMENCING WORK ON SITE.

PREPARE TREE HOLES TO A MINIMUM SIZE OF THE DEPTH OF THE ROOTBALL x 1m WIDE AND BREAK THE SUBGRADE TO A MINIMUM DEPTH OF 200MM BELOW. TAKE PARTICULAR CARE TO BREAK UP ANY GLAZING TO SIDES OF TREE HOLE. FINISH THE ROOTBALL LEVEL WITH THE FINAL SURROUNDING SOIL LEVEL AND BACKFILL THE PLANTING HOLE WITH SITE TOPSOIL BLENDED WITH 20% ORGANIC MIX. PROVIDE A 1m DIAMETER MULCHED WATERING BOWL TO THE BASE OF THE TREE. STAKE TREES WITH 2No. 2500x50x50 HARDWOOD STAKES AND TIE WITH 50mm HESSIAN TIES SECURELY STAPLED TO THE STAKES. ENSURE STAKES AND TIES REMAIN CLEAR OF BRANCHES, FOLIAGE AND ROOTBALL.

PLANTING BEDS

CULTIVATE EXISTING GROUND TO A MINIMUM DEPTH OF 300 MM AND PLACE 300MM IMPORTED 'ORGANIC MIX'. PLACE PLANTS IN THE CENTER OF THE PLANTING HOLE AND FINISH THE TOP OF THE ROOT BALL LEVEL WITH THE FINISHED SURFACE OF THE SURROUNDING SOIL. APPLY TERRACOTTEM FERTILISER TO MANUFACTURERS RATES AT TIME OF PLANTING AND AFTER PLANTING PLACE A 100MM MINIMUM DEPTH OF COTTAGE MULCH. THOROUGHLY WATER PLANTS BEFORE AND IMMEDIATELY AFTER PLANTING, AND AS REQUIRED TO MAINTAIN HEALTH AND VIGOUR. AVERAGE 1.5 PLANTS/M²

<u>IRRIGATION</u>

10mm ARIS TO ALL EDGES—

SCALE 1:10 @ A1

SCALE 1:10 @ A1

ALL PLANTING HOLES TO BE

AND FILL WITH TOPSOIL OR


EXCAVATED TO NATURAL GROUND.


REMOVE ALL DELETERIOUS MATERIAL

PROVIDE AN AUTOMATIC IN-LINE DRIP IRRIGATION SYSTEM TO

ALL PLANTING BEDS AND TREES. DRIP IRRIGATION SPECIFIED AS NETAFIM TECHLINE 16 POLY TUBE 1.6Lph @ 0.5M SPACINGS OR SIMILAR APPROVED. FOR ALL TREE PLANTING INSTALL AT BASE OF TREE 4No 4Lph PC DRIP EMITTERS ON 13MM POLY LOOP (OR INLINE EQUIVALENT).

ALL POLY TUBING TO BE LAID ON SURFACE AND COVERED WITH MULCH.

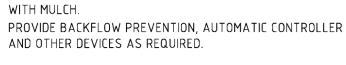

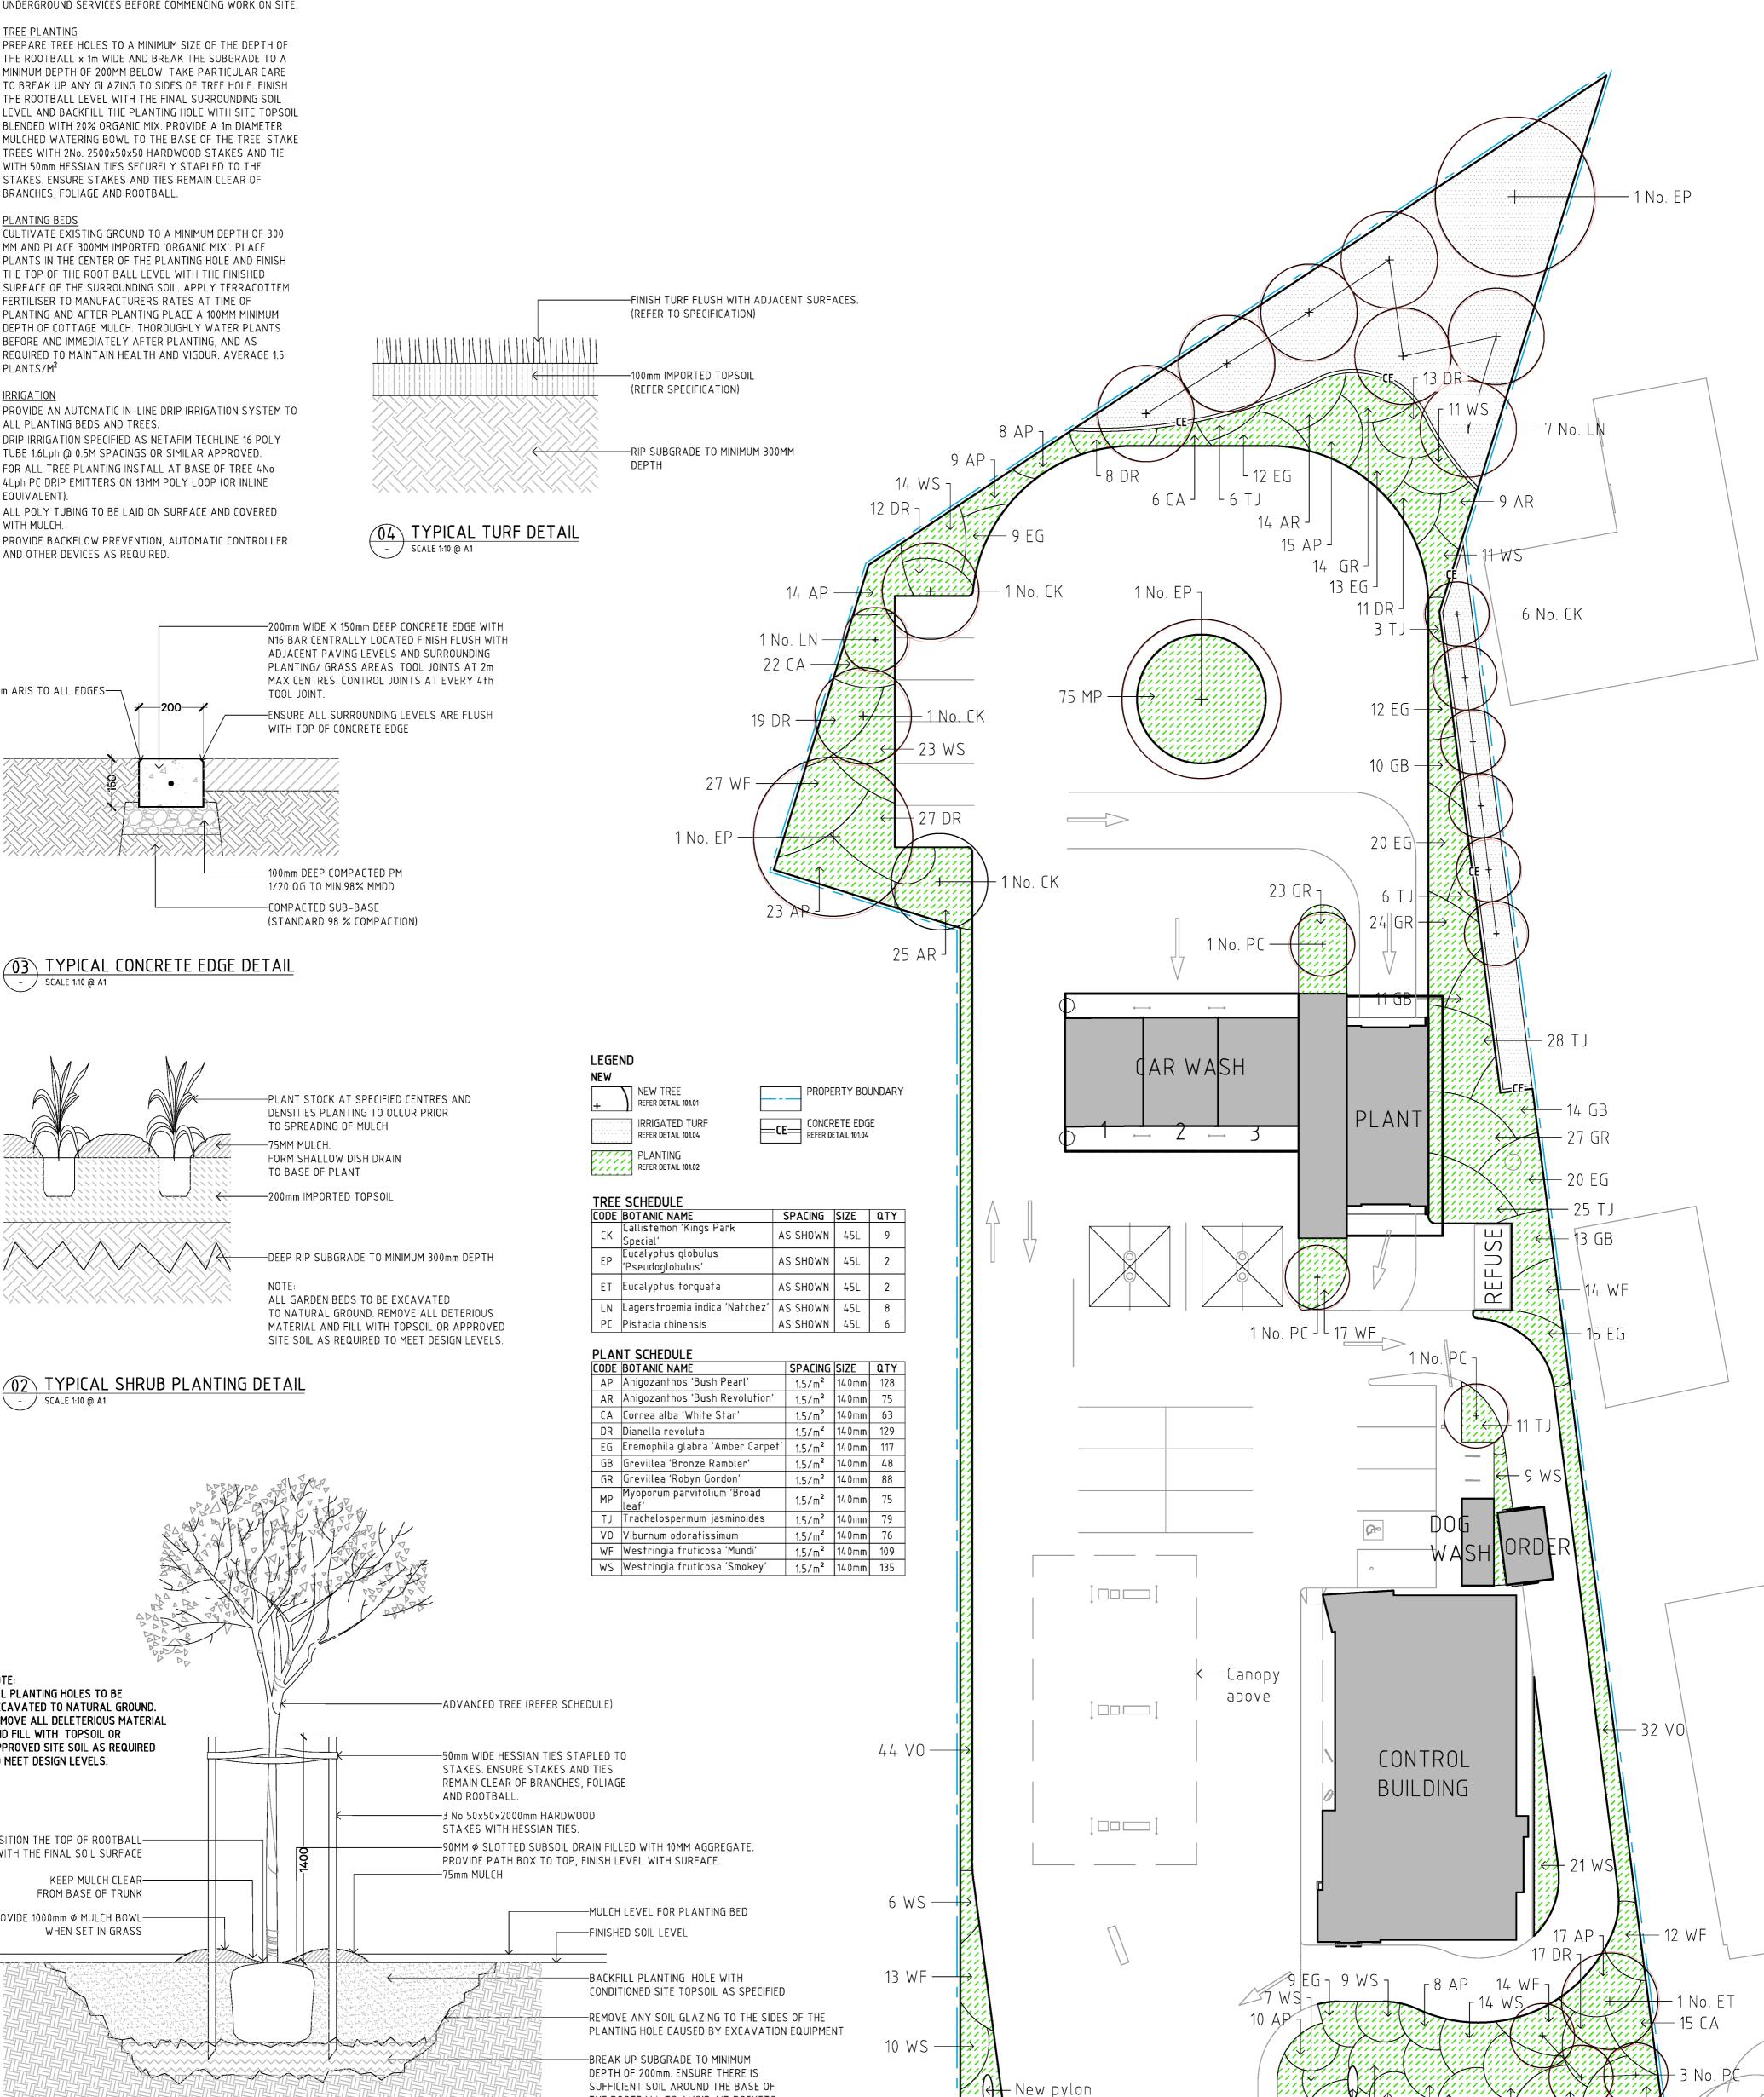

APPROVED SITE SOIL AS REQUIRED TO MEET DESIGN LEVELS. POSITION THE TOP OF ROOTBALL-LEVEL WITH THE FINAL SOIL SURFACE KEEP MULCH CLEAR-FROM BASE OF TRUNK PROVIDE 1000mm Ø MULCH BOWL-WHEN SET IN GRASS SUFFICIENT SOIL AROUND THE BASE OF

1 TYPICAL TREE IN MULCH DETAIL SCALE 1:20 @ A1

1:200 (A1), 1:400 (A3) Drawing Title **LANDSCAPE PLAN 101**

THE ROOTBALL TO AVOID AIR POCKETS

AND FUTURE SUBSIDENCE.

12 WF

Existing crossover

7 EG - 7 AP

MONBULK ROAD

New pylon ^J

12 AR ^{J L} 9 CA

Project number Revision Date 19.08.22 15.047.095 В

- 17 AP ^L 11 DR

^L 11 CA

- 11 DR